

Appendix 1-A Avocado Site Drawings

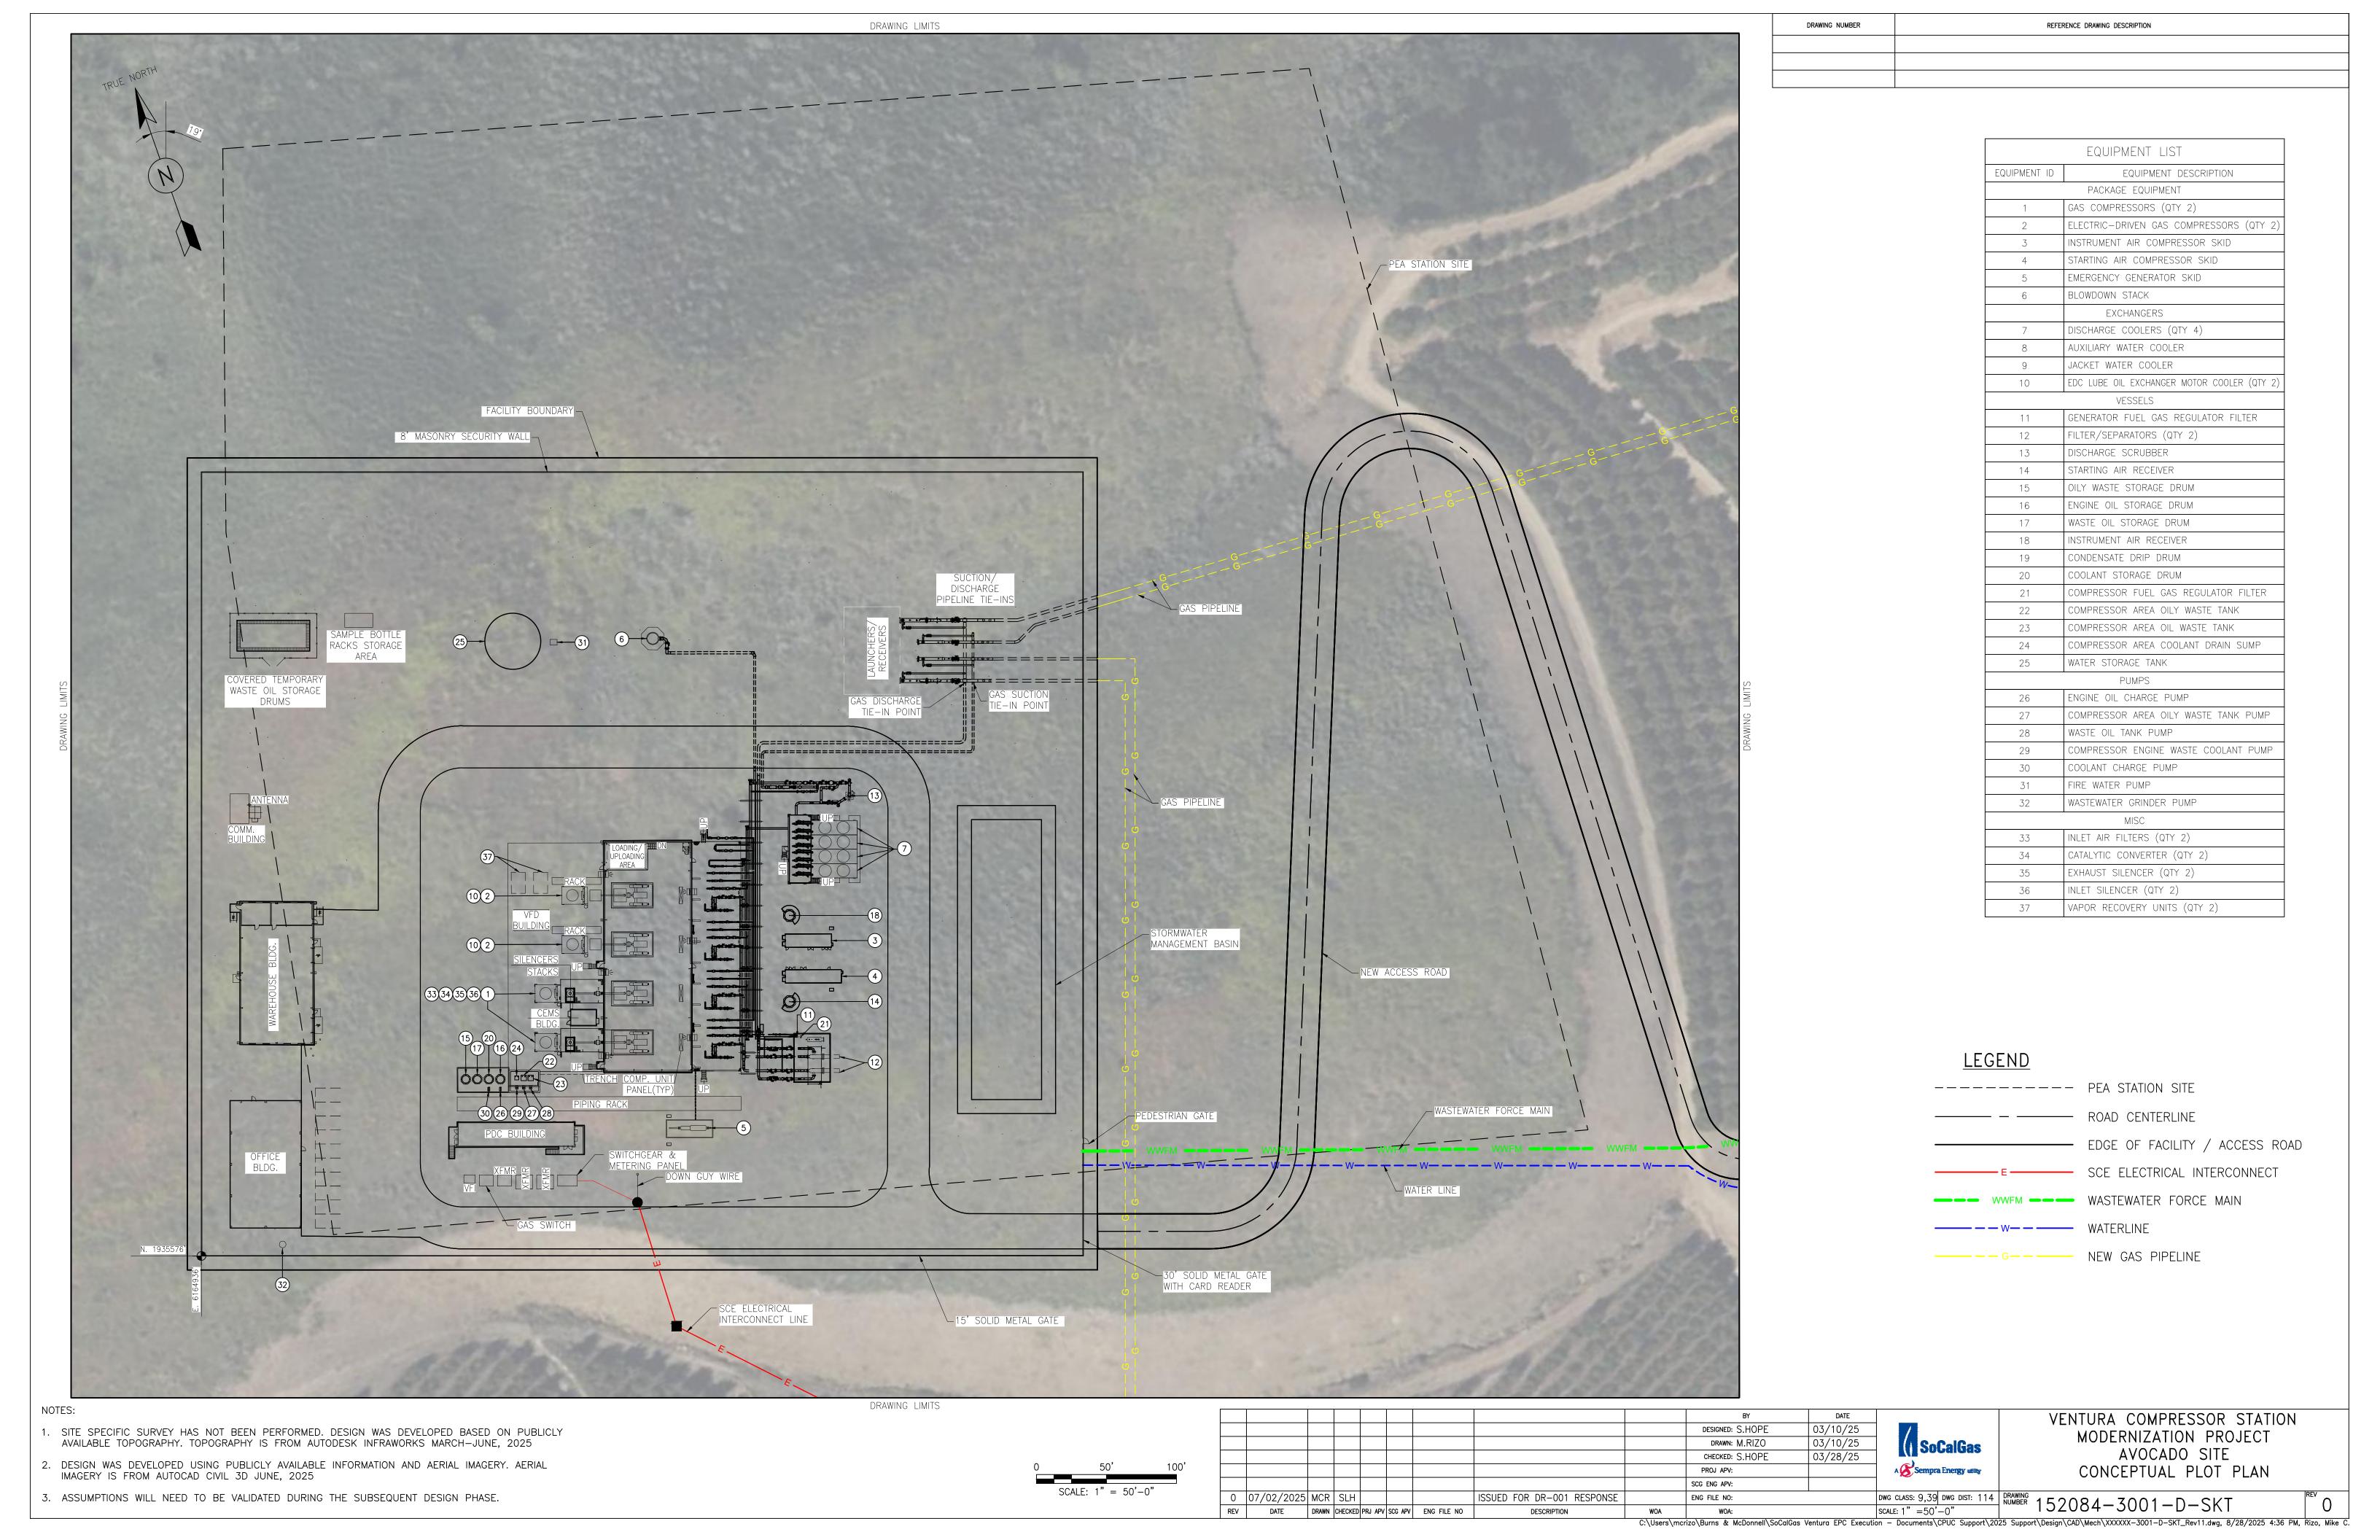

	DRAWING NUMBER	REFERENCE DRAWING DESCRIPTION
	152084-7131-D-SKT	ROAD & UTILITY TRENCH DETAILS
١		

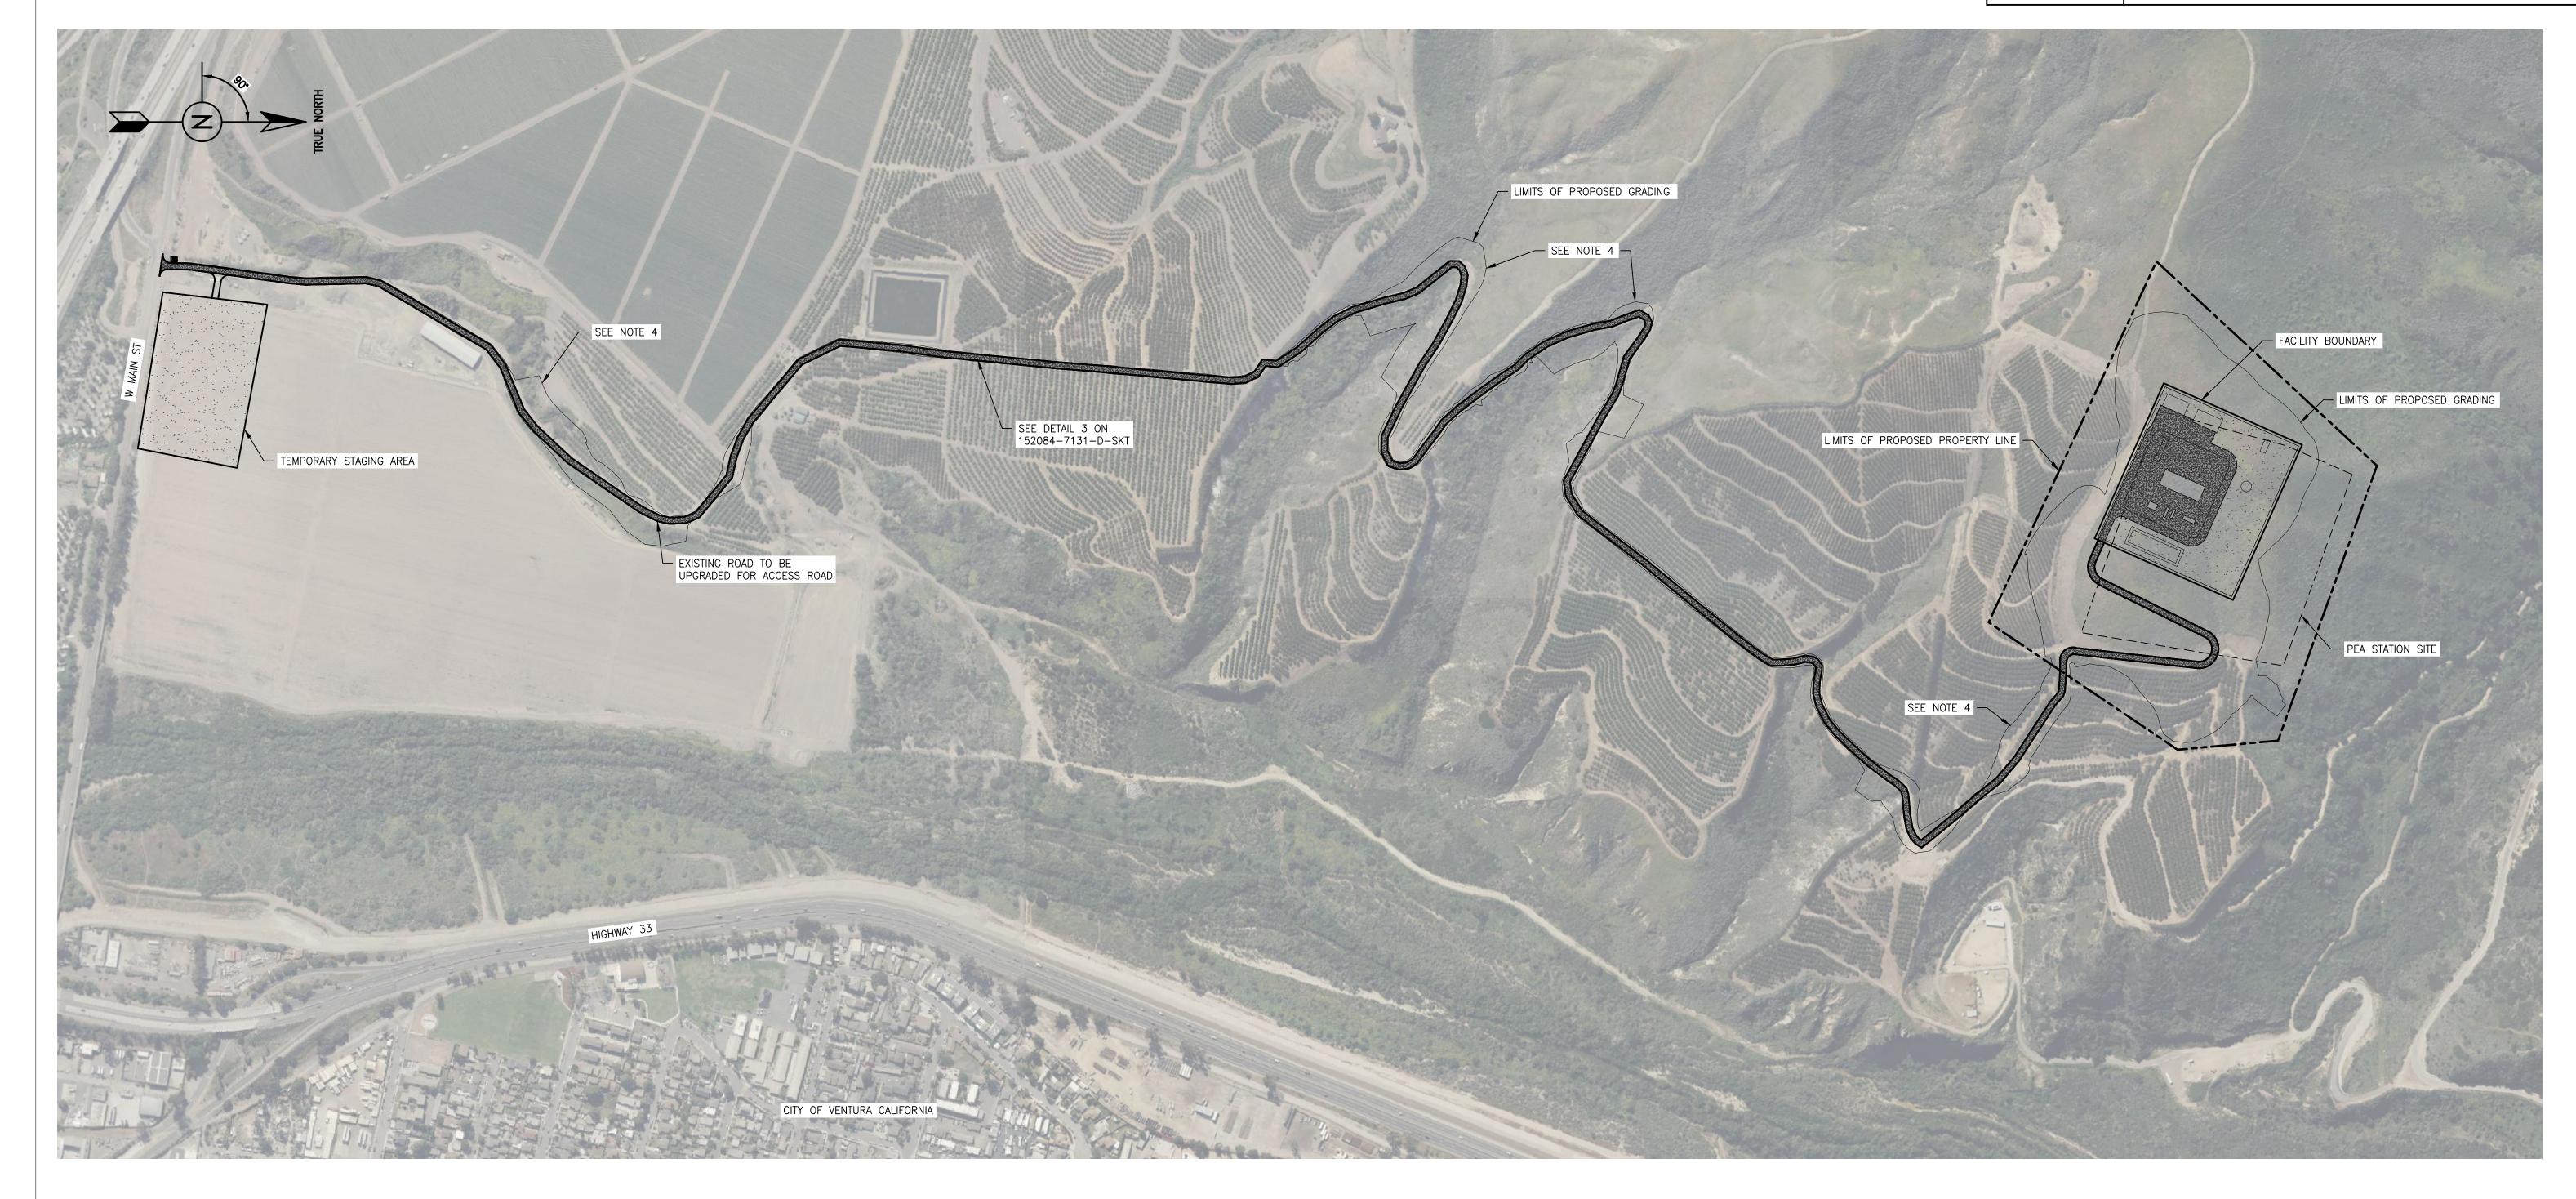

<u>LEGEND</u>

----- PEA STATION SITE

LIMITS OF PROPOSED GRADING

EDGE OF FACILITY / ACCESS ROAD

----- LIMITS OF PROPOSED PROPERTY LINE


AGGREGATE SURFACING

C:\Users\mcrizo\Burns & McDonnell\SoCalGas Ventura EPC Execution — Documents\CPUC Support\Design\Civil — Structural\CAD\Avocado\152084—7001—D—SKT.dwg, 8/1/2025 2:40 PM, Rizo, Mike C.


ASPHALT OR OTHER PAVEMENT

NOTES:

- 1. SITE SPECIFIC SURVEY HAS NOT BEEN PERFORMED. DESIGN WAS DEVELOPED BASED ON PUBLICLY AVAILABLE TOPOGRAPHY. TOPOGRAPHY IS FROM AUTODESK INFRAWORKS MARCH—JUNE, 2025
- 2. DESIGN WAS DEVELOPED USING PUBLICLY AVAILABLE INFORMATION AND AERIAL IMAGERY. AERIAL IMAGERY IS FROM AUTOCAD CIVIL 3D JUNE, 2025
- 3. ASSUMPTIONS WILL NEED TO BE VALIDATED DURING THE SUBSEQUENT DESIGN PHASE.
- 4. ALL DISTURBED SURFACES NOT COVERED WITH AGGREGATE, ASPHALT, CONCRETE, OR OTHER PERMANENT SURFACING SHALL BE SEEDED AND AN EROSION CONTROL BLANKET SHALL BE INSTALLED. THE TYPE OF EROSION CONTROL BLANKET AND SEED MIXTURE WILL BE DETERMINED DURING DETAILED DESIGN.

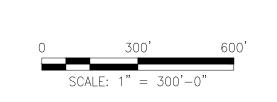


						BY DESIGNED: J.BAKKER DRAWN: M.RIZO CHECKED: S.HOPE PROJ APV: SCG ENG APV:	DATE 06/15/25 06/15/25 06/20/25	Sempra Energy utility	VENTURA COMPRESSOR STATION MODERNIZATION PROJECT AVOCADO SITE CONCEPTUAL OVERALL SURFACING PLAN
07/02/2025	MCR	JBB		ISSUED FOR DR-001 RESPONSE		ENG FILE NO: E15043		DWG CLASS: 9,39 DWG DIST: 114	DRAWING NUMBER 152084-7001-D-SKT 0
DATE	DRAWN	CHECKED	PRJ APV SCG APV	ENG FILE NO DESCRIPTION	WOA	WOA:		SCALE: $1" = 300' - 0"$	132004-7001-D-3KI 0

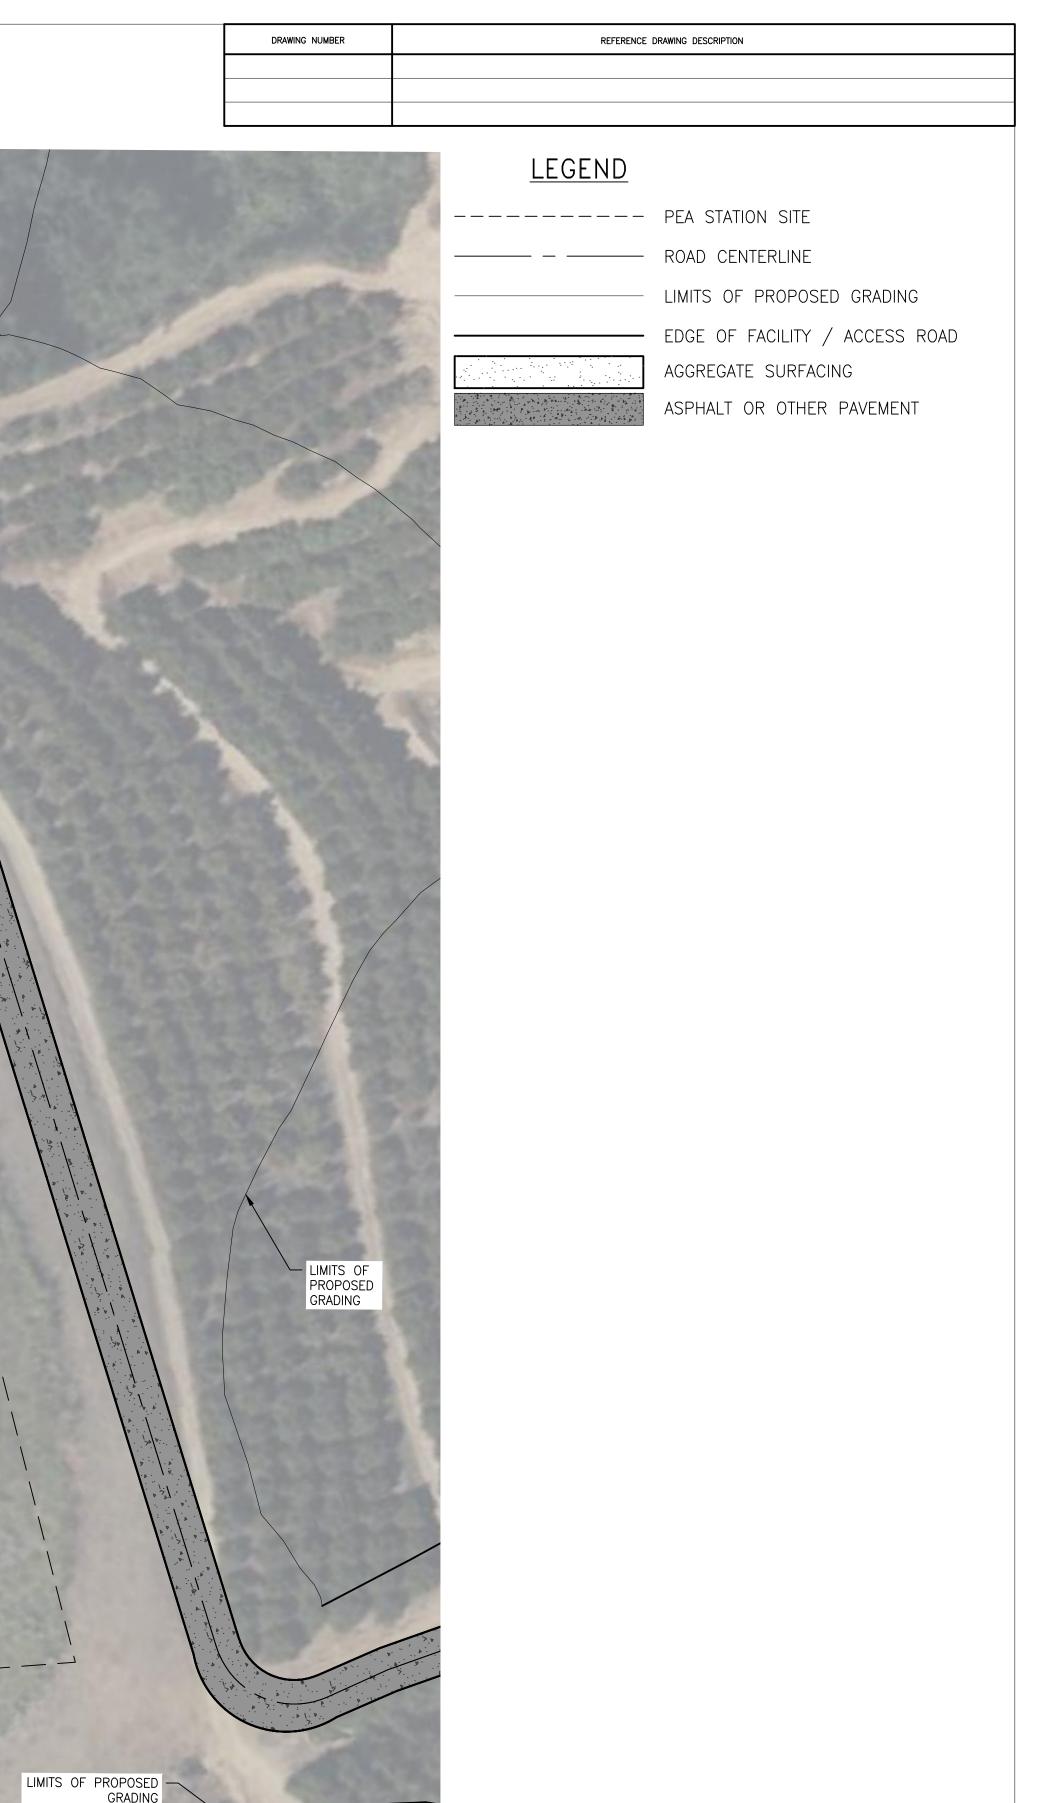



- TOPOGRAPHY. TOPOGRAPHY IS FROM AUTODESK INFRAWORKS MARCH—JUNE, 2025
- 2. DESIGN WAS DEVELOPED USING PUBLICLY AVAILABLE INFORMATION AND AERIAL IMAGERY. AERIAL IMAGERY IS FROM AUTOCAD CIVIL 3D JUNE, 2025
- 3. ASSUMPTIONS WILL NEED TO BE VALIDATED DURING THE SUBSEQUENT DESIGN PHASE.
- 4. ALL DISTURBED SURFACES NOT COVERED WITH AGGREGATE, ASPHALT, CONCRETE, OR OTHER PERMANENT SURFACING SHALL BE SEEDED AND AN EROSION CONTROL BLANKET SHALL BE INSTALLED. THE TYPE OF EROSION CONTROL BLANKET AND SEED MIXTURE WILL BE DETERMINED DURING DETAILED DESIGN.

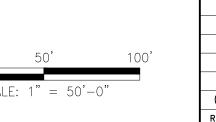

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									DRAWN: M.RIZO	06/15/25	SoCalGas
									CHECKED: S.HOPE	06/20/25	
									PROJ APV:		A Sempra Energy willy
									SCG ENG APV:		
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VENTURA COMPRESSOR STATION
MODERNIZATION PROJECT
AVOCADO SITE
CONCEPTUAL SITE SURFACING PLAN

WOA:

SCALE: 1" = 50'-0"

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REFERENCE DRAWING DESCRIPTION DRAWING NUMBER <u>LEGEND</u>



— — — — PEA STATION SITE

— — ROAD CENTERLINE

— EDGE OF FACILITY / ACCESS ROAD

- 5530 ---- MAJOR CONTOUR

---- 5530 --- EXISTING MAJOR CONTOUR


----- EXISTING MINOR CONTOUR

NOTES:

1. SITE SPECIFIC SURVEY HAS NOT BEEN PERFORMED. DESIGN WAS DEVELOPED BASED ON PUBLICLY AVAILABLE TOPOGRAPHY. TOPOGRAPHY IS FROM AUTODESK INFRAWORKS MARCH—JUNE, 2025

2. DESIGN WAS DEVELOPED USING PUBLICLY AVAILABLE INFORMATION AND AERIAL IMAGERY. AERIAL IMAGERY IS FROM AUTOCAD CIVIL 3D JUNE, 2025

3. ASSUMPTIONS WILL NEED TO BE VALIDATED DURING THE SUBSEQUENT DESIGN PHASE.

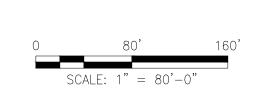


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									CHECKED: S.HOPE	06/20/25	
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VENTURA COMPRESSOR STATION
MODERNIZATION PROJECT
AVOCADO SITE
CONCEPTUAL GRADING PLAN

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<u>LEGEND</u>

---- PEA STATION SITE

—— EDGE OF FACILITY / ACCESS ROAD

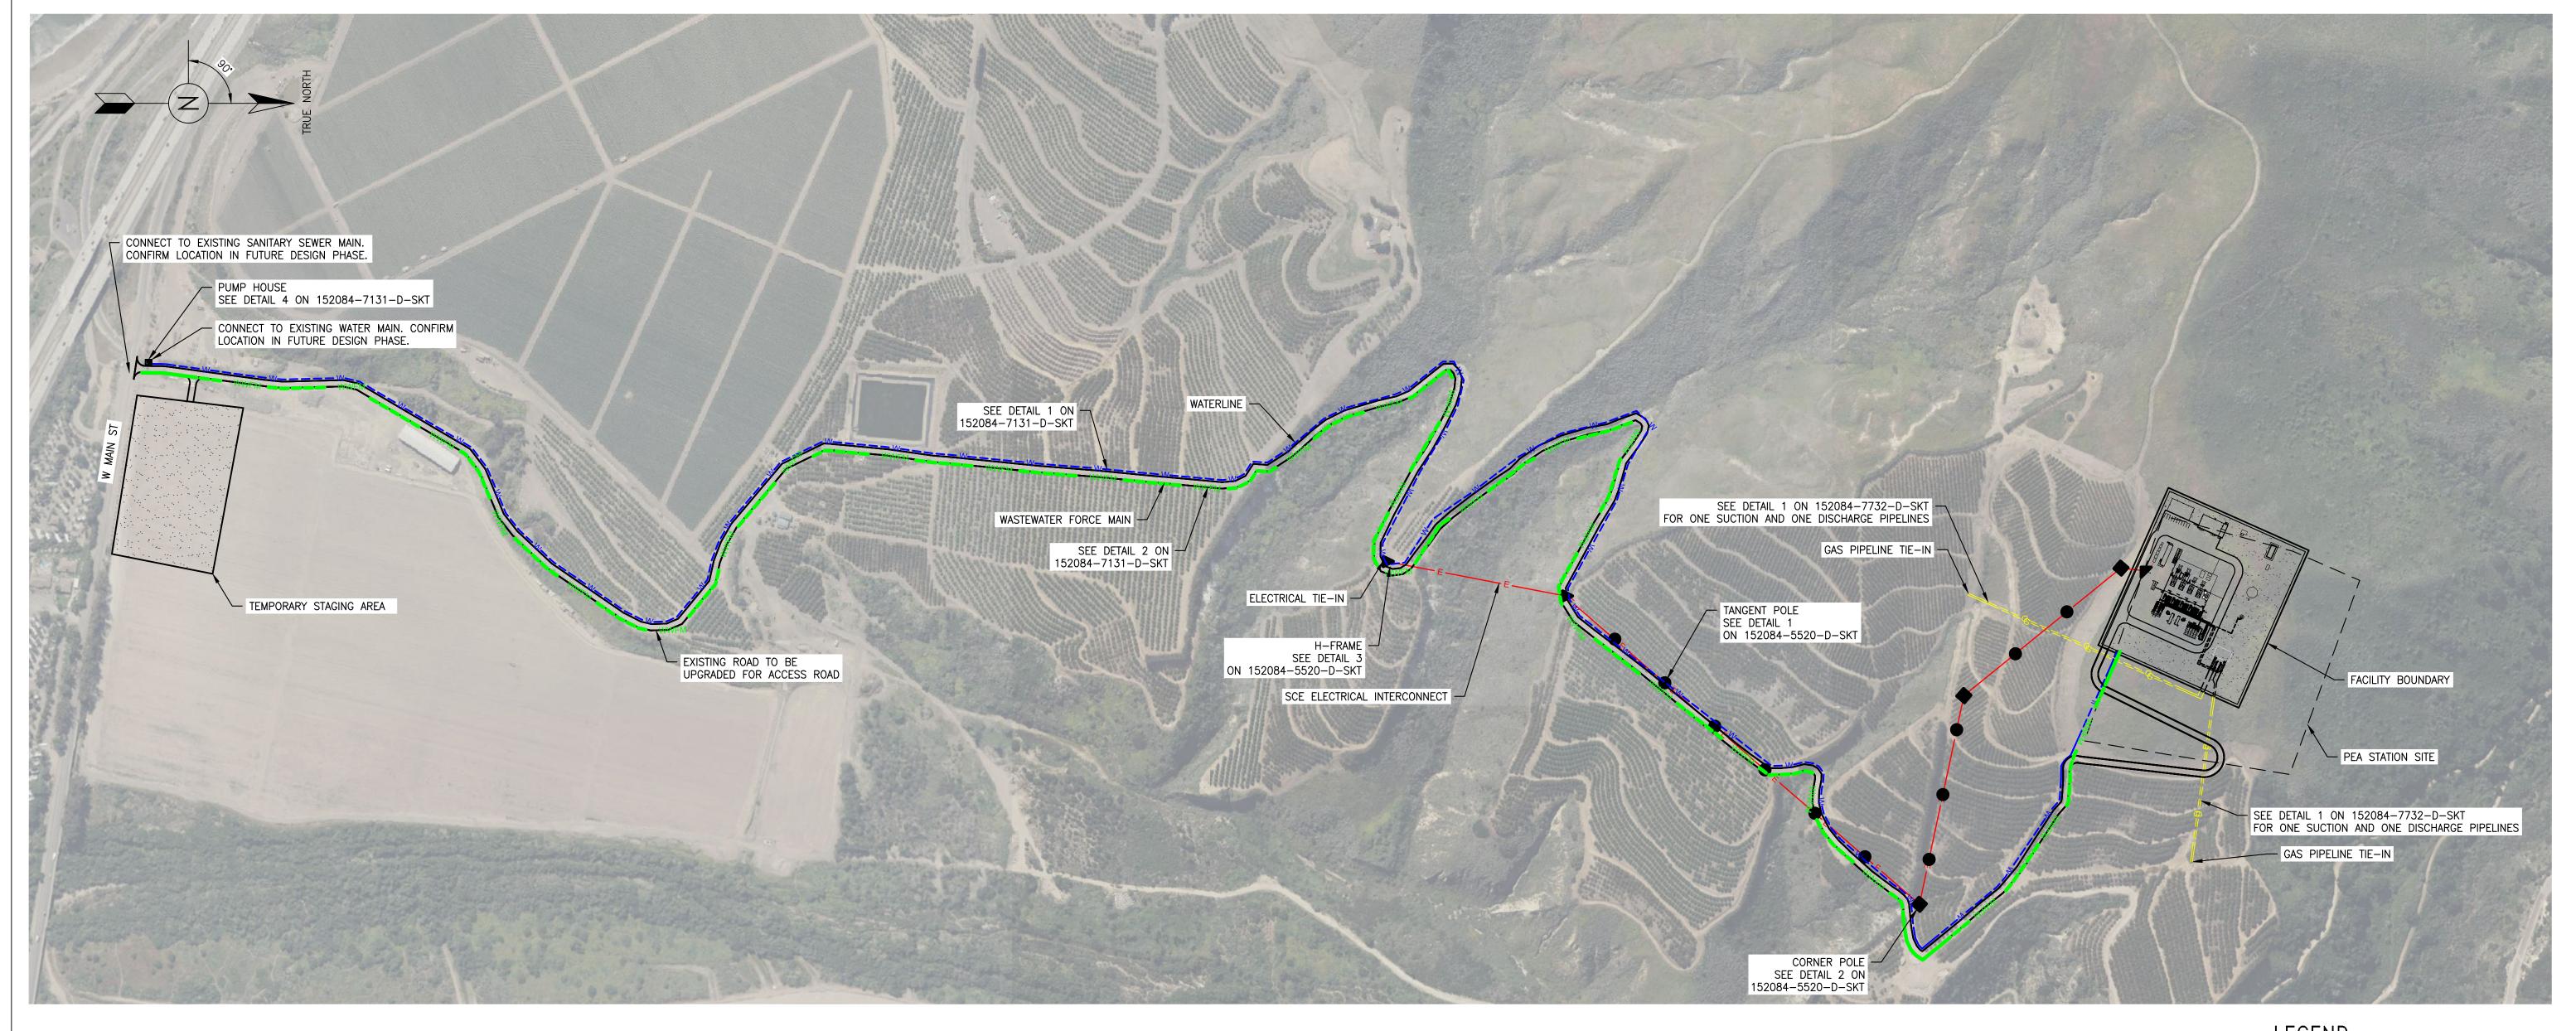--- WWFM --- WASTEWATER FORCE MAIN

— — — WATERLINE

NEW GAS PIPELINE

SCE ELECTRICAL INTERCONNECT

H FRAME

TANGENT POLE

CORNER POLE


DEAD END POLE

NOTES:

1. SITE SPECIFIC SURVEY HAS NOT BEEN PERFORMED. DESIGN WAS DEVELOPED BASED ON PUBLICLY AVAILABLE TOPOGRAPHY. TOPOGRAPHY IS FROM AUTODESK INFRAWORKS MARCH—JUNE, 2025

2. DESIGN WAS DEVELOPED USING PUBLICLY AVAILABLE INFORMATION AND AERIAL IMAGERY. AERIAL IMAGERY IS FROM AUTOCAD CIVIL 3D JUNE, 2025

3. ASSUMPTIONS WILL NEED TO BE VALIDATED DURING THE SUBSEQUENT DESIGN PHASE.

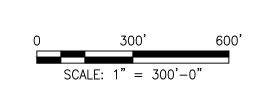

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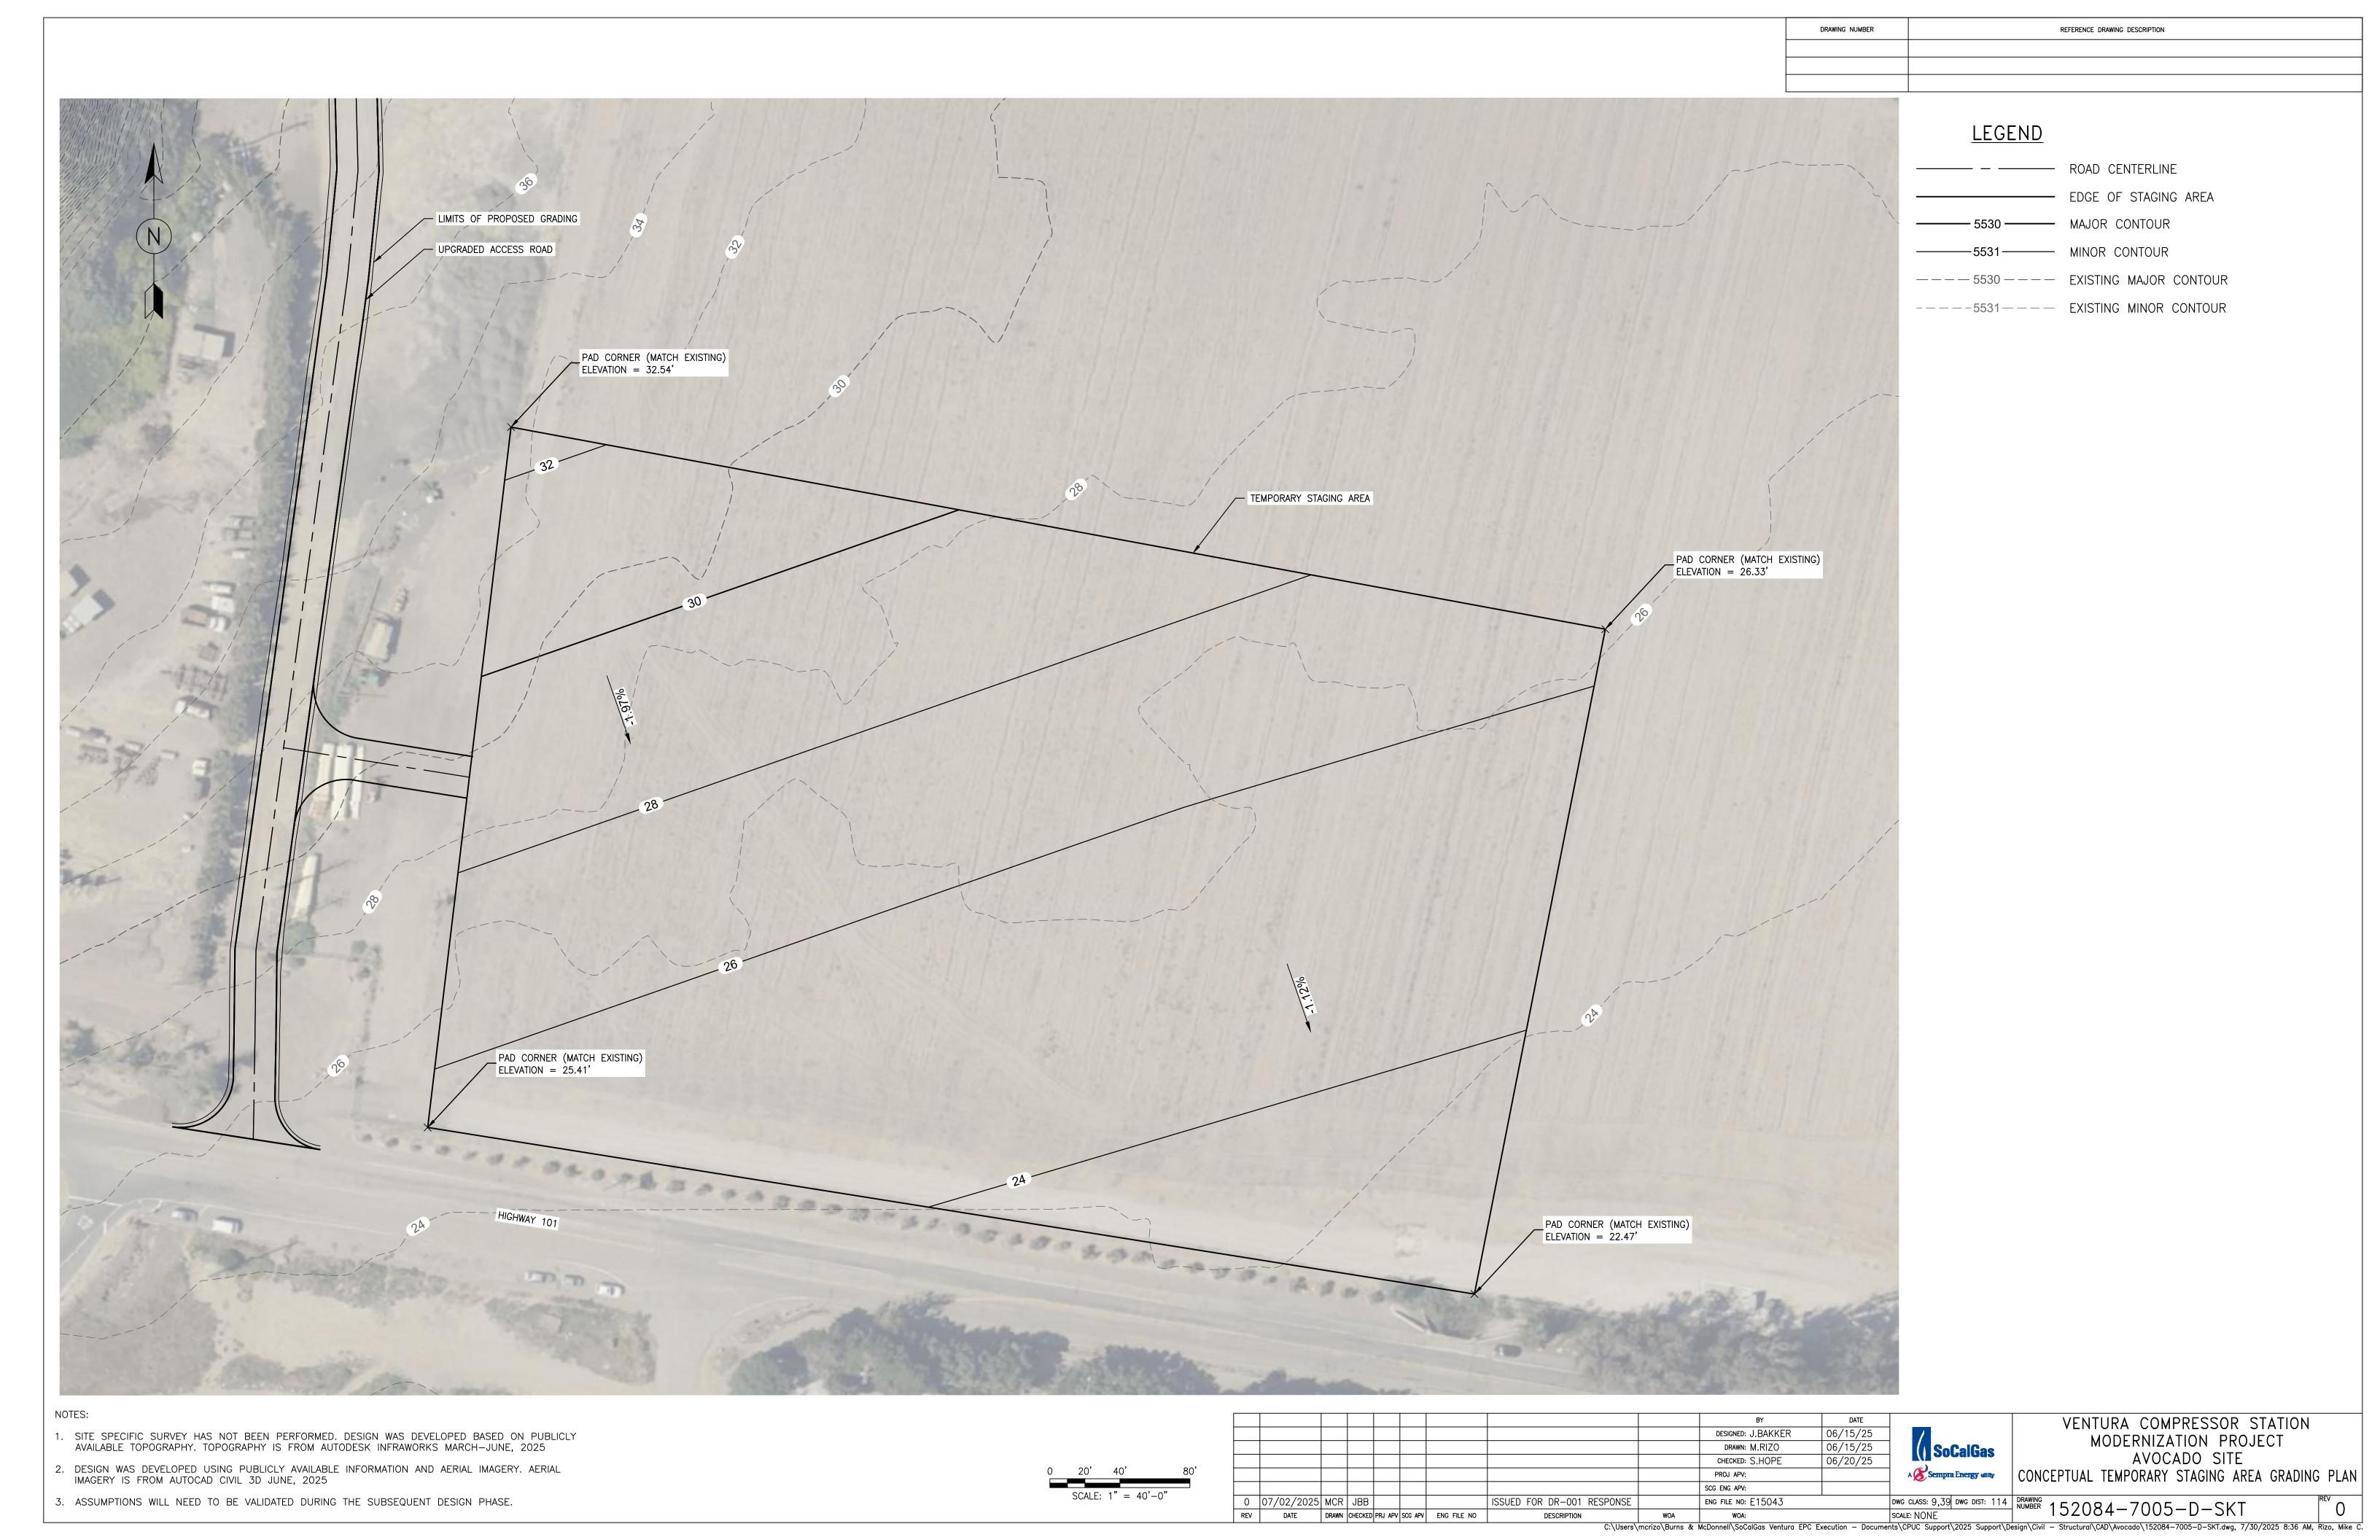



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VENTURA COMPRESSOR STATION MODERNIZATION PROJECT AVOCADO SITE CONCEPTUAL PIPELINE & UTILITY PLAN

9,39 DWG DIST: 114 DRAWING NUMBER 152084-7004-D-SKT

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DRAWING NUMBER	REFERENCE DRAWING DESCRIPTION



<u>LEGEND</u>

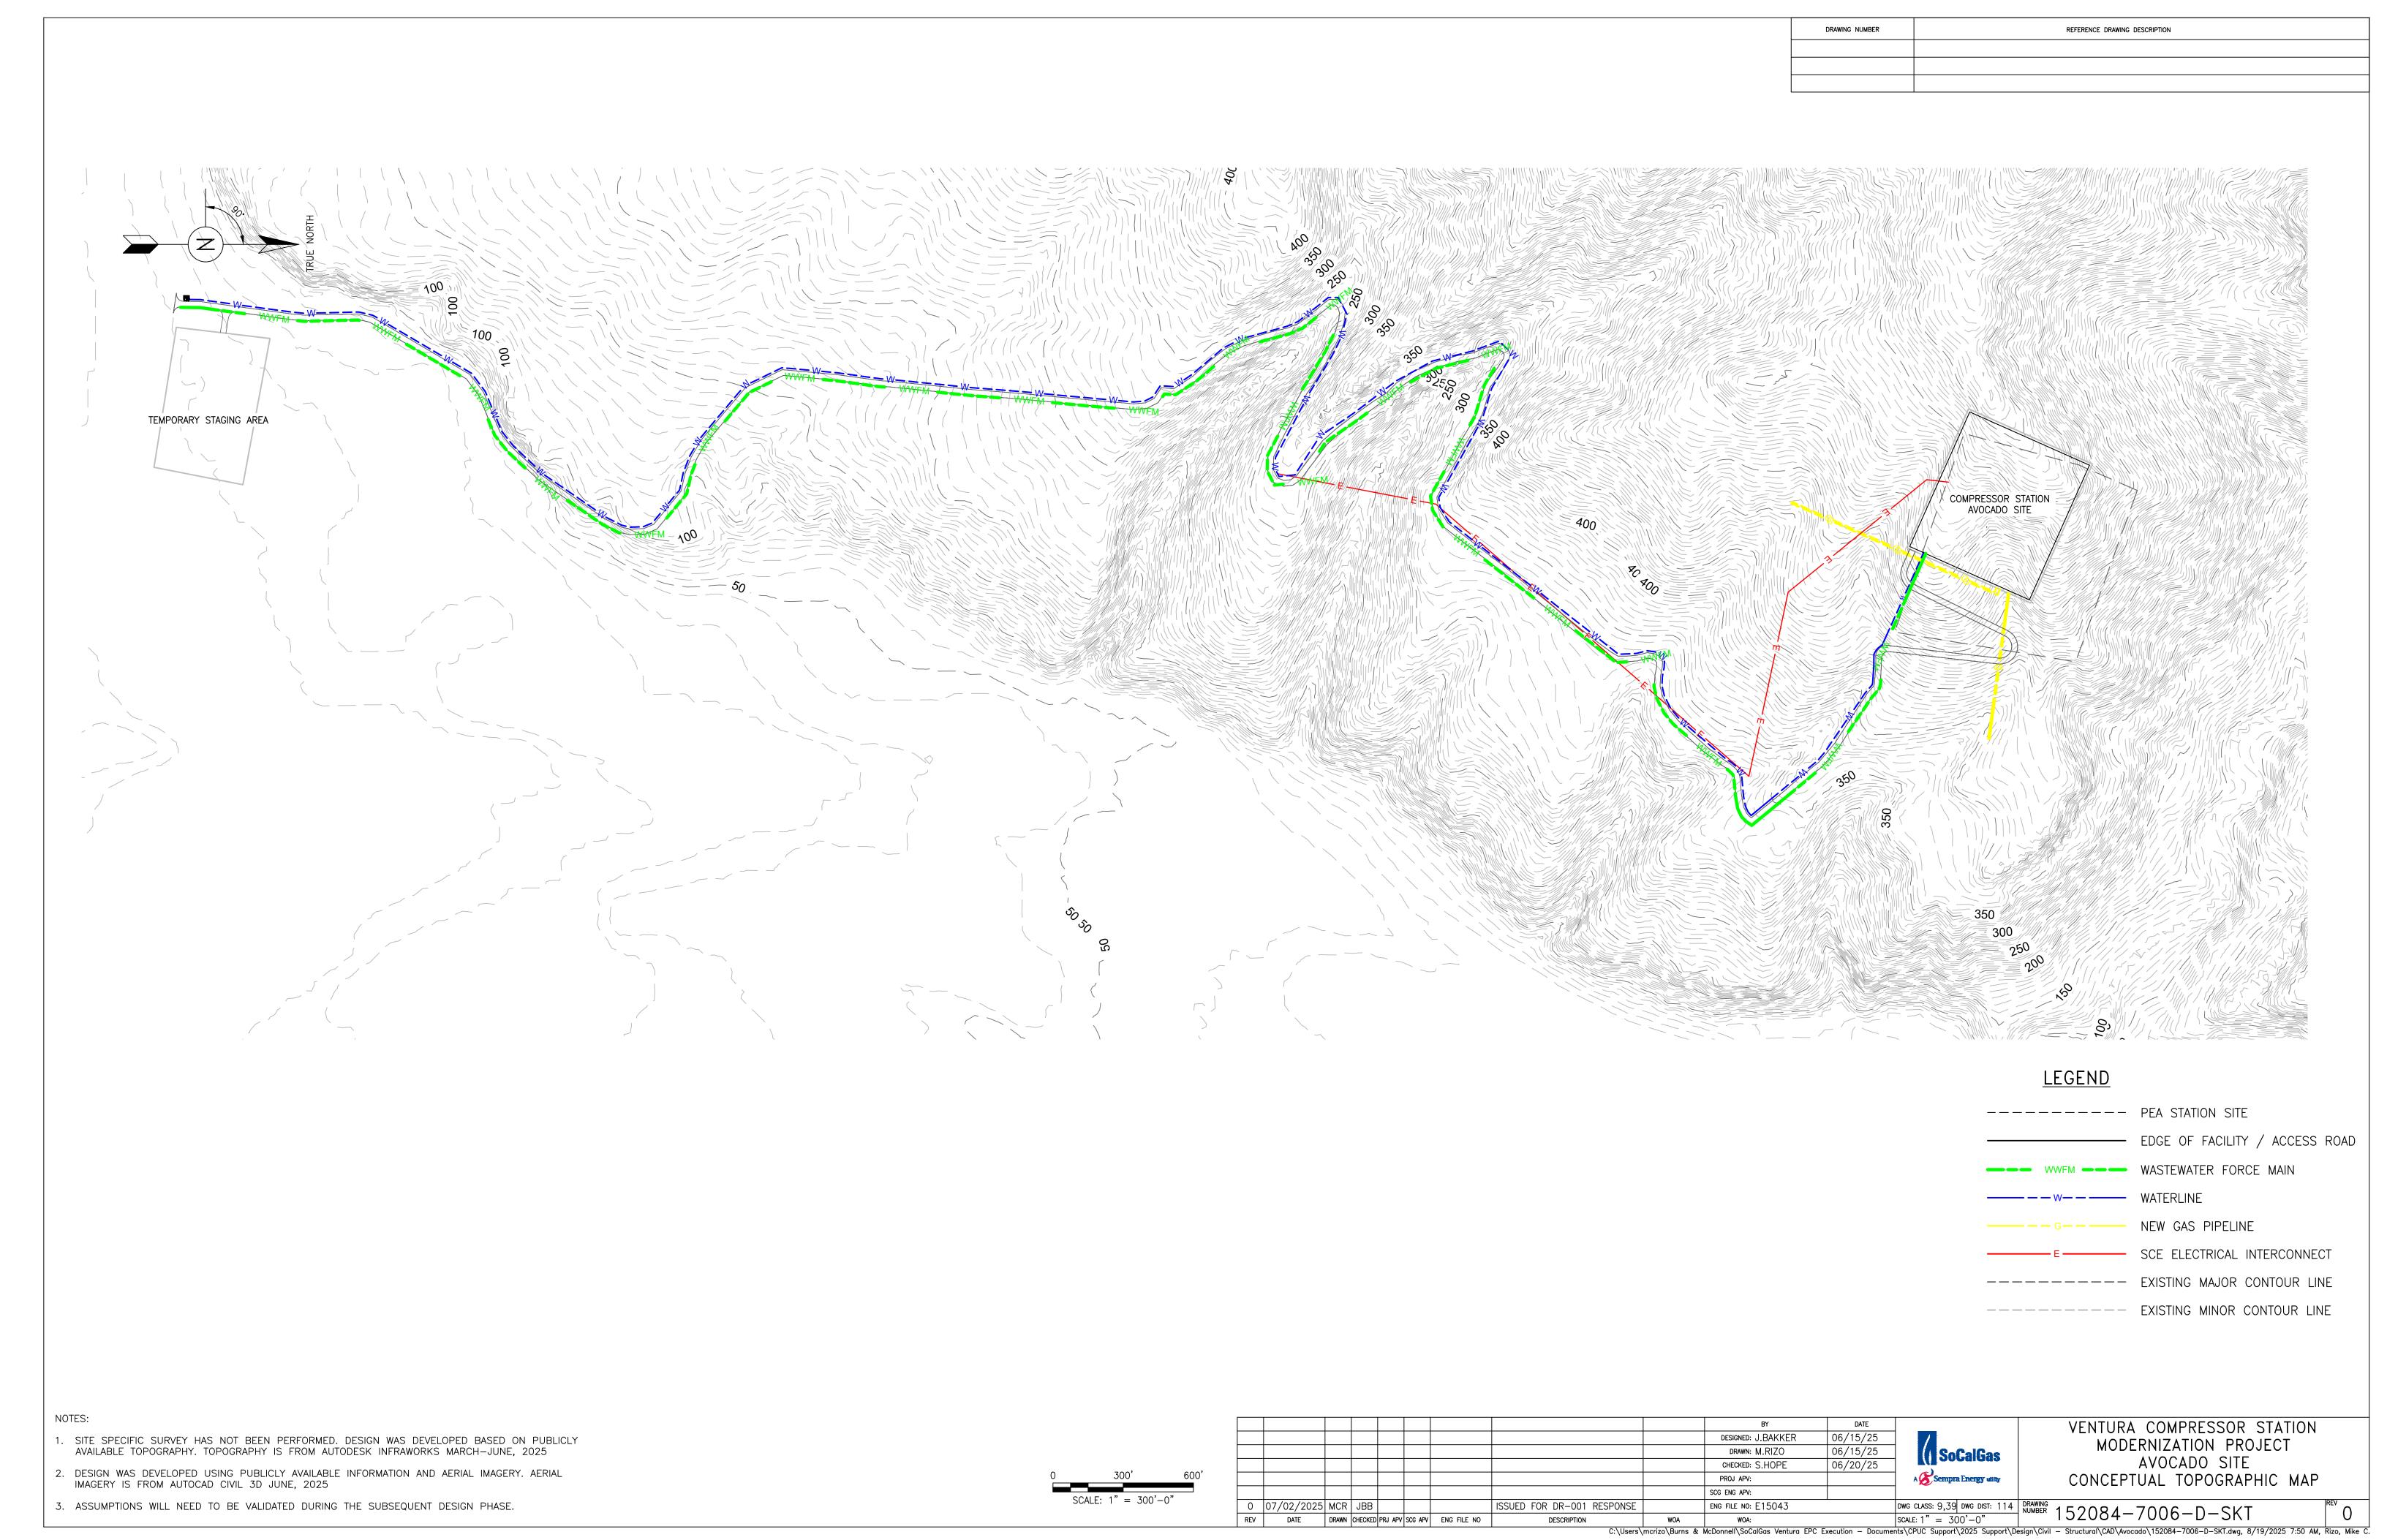EDGE OF FACILITY

PERMANENT LIMITS OF DISTURBANCE


TEMPORARY LIMITS OF DISTURBANCE

NOTES:

1. SITE SPECIFIC SURVEY HAS NOT BEEN PERFORMED. DESIGN WAS DEVELOPED BASED ON PUBLICLY AVAILABLE TOPOGRAPHY. TOPOGRAPHY IS FROM AUTODESK INFRAWORKS MARCH—JUNE, 2025

2. DESIGN WAS DEVELOPED USING PUBLICLY AVAILABLE INFORMATION AND AERIAL IMAGERY. AERIAL IMAGERY IS FROM AUTOCAD CIVIL 3D JUNE, 2025

3. ASSUMPTIONS WILL NEED TO BE VALIDATED DURING THE SUBSEQUENT DESIGN PHASE.

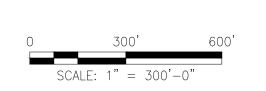


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						DESIGNED: J.BAKKER	06/15/25	/	
						DRAWN: M.RIZO	06/15/25	SoCalGas	
						CHECKED: S.HOPE	06/20/25		
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VENTURA COMPRESSOR STATION
MODERNIZATION PROJECT
AVOCADO SITE
CONCEPTUAL LIMITS OF DISTURBANCE

ESPONSE | ENG FILE NO: E15043 | DWG CLASS: 9,39 | DWG DIST: 114 | MOA | WOA: | SCALE: 1" = 300'-0" | 152084-7007-D-SKT | O | C:\Users\mcrizo\Burns & McDonnell\SoCalGas Ventura EPC Execution - Documents\CPUC Support\2025 Support\Design\Civil - Structural\CAD\Avocado\152084-7007-D-SKT.dwg, 7/31/2025 2:44 PM, Rizo, Mike C.



10' CROSSARM -

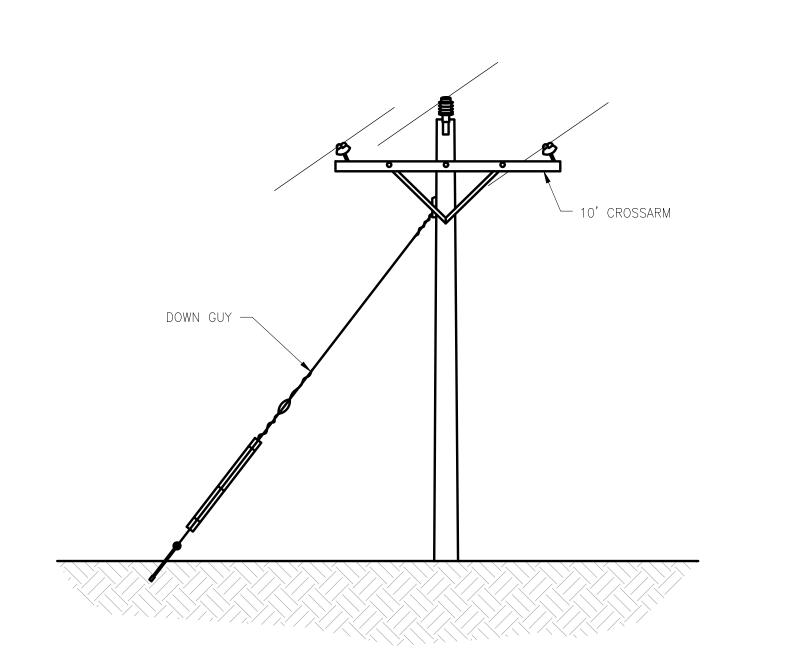20'-0" 10'-0"

DRAWING NUMBER

152084-7004-D-SKT

REFERENCE DRAWING DESCRIPTION

CONCEPTUAL PIPELINE & UTILITY PLAN

NOTES:

1. SEE DETAIL 4, THIS SHEET FOR POLE HOLE AND ANCHOR DEPTHS.

NOTES:

1. TYPICAL TANGENT POLE WITH SIDE GUY IF SLIGHT ANGLE ON THE LINE. 2. MOST ALL TANGENT POLES WILL NOT HAVE SIDE GUYS. 3. SEE DETAIL 4, THIS SHEET FOR POLE HOLE AND ANCHOR DEPTHS.


NOTES:

1. DOWN GUYS ARE NOT SHOWN 2. SEE DETAIL 4, THIS SHEET FOR POLE HOLE AND ANCHOR DEPTHS.

TANGENT AND ANGLE POLE

CORNER POLE

H-FRAME

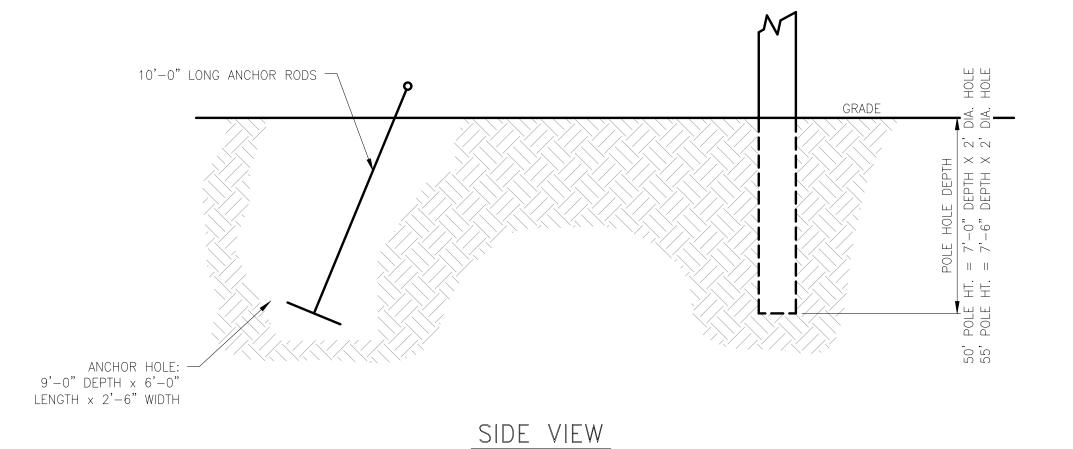


NOTES:

1. SEE DETAIL 5, THIS SHEET FOR POLE HOLE AND ANCHOR PLAN VIEW

ELECTRICAL POLE ANCHOR & POLE HOLE DEPTH

DETAIL 4

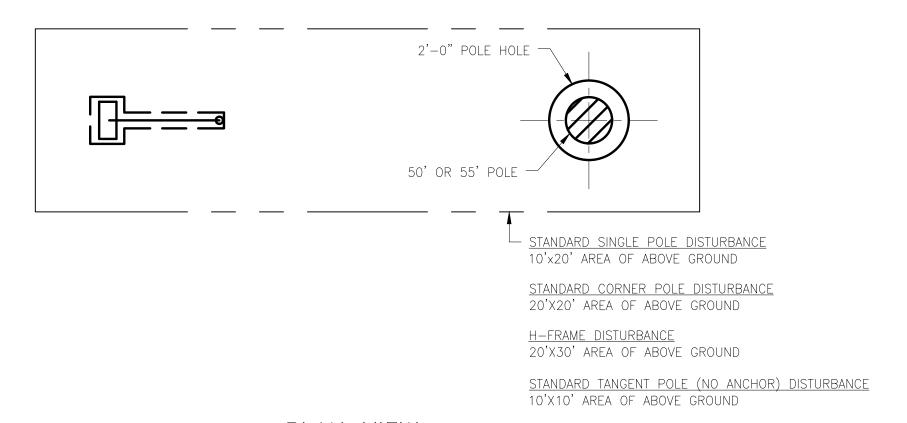

PLAN VIEW

ELECTRICAL POLE LIMITS OF DISTURBANCE


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								BY	DATE		VENTURA COMPRESSOR S
								DESIGNED: J.RIFFEL	05/10/25		MODERNIZATION PROJ
								DRAWN: M.RIZO	05/10/25	SoCalGas	
								CHECKED: S.HOPE	05/11/25	Management	AVOCADO SITE
								PROJ APV:		A Sempra Energy utility	ELECTRICAL DISTR. INTERCONNECT PRE
								SCG ENG APV:			
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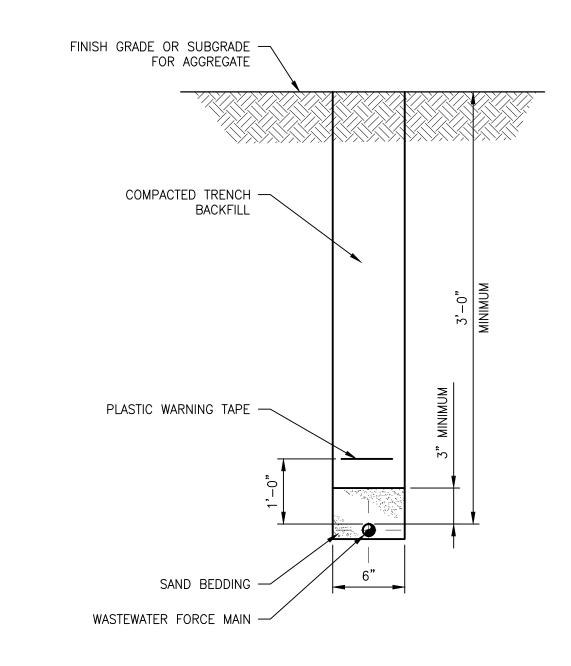
VENTURA COMPRESSOR STATION MODERNIZATION PROJECT AVOCADO SITE ELECTRICAL DISTR. INTERCONNECT PRELIMINARY DETAILS

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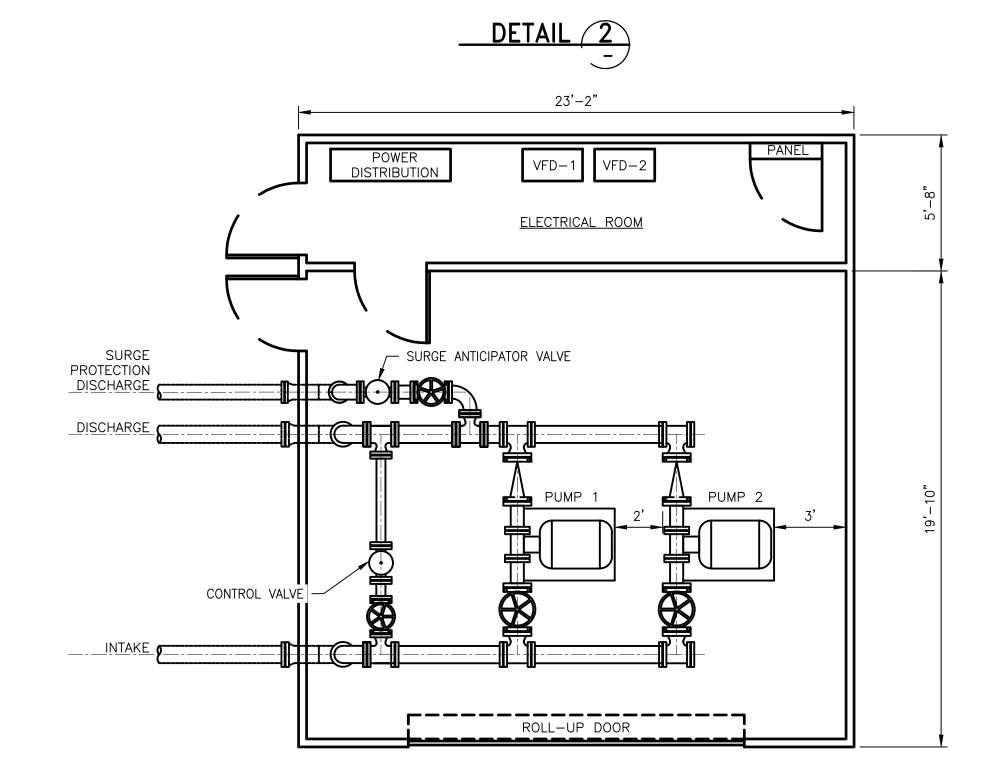
CONSULT SOUTHERN CALIFORNIA EDISON'S ESR MANUAL, SECTIONS 19.0 THROUGH 20.10 IN CHAPTER ESR-7, FIGURE 7-1.

1. FOR PRIMARY SERVICE EQUIPMENT SPECIFICATIONS AND REQUIREMENTS,



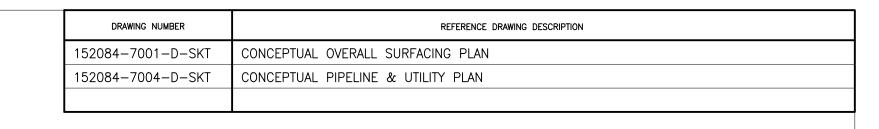

TYPICAL WASTEWATER TRENCH



PUMP HOUSE GENERAL ARRANGEMENT




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FINISH GRADE OR SUBGRADE FOR AGGREGATE		
COMPACTED TRENCH BACKFILL		
PLASTIC WARNING TAPE	3,-0," MINIMUM	
WATERLINE	-1-0-1-	
	OD PIPE	
PIPE BEDDING MATERIAL		
	6" MINIMUM	

TYPICAL WATER TRENCH



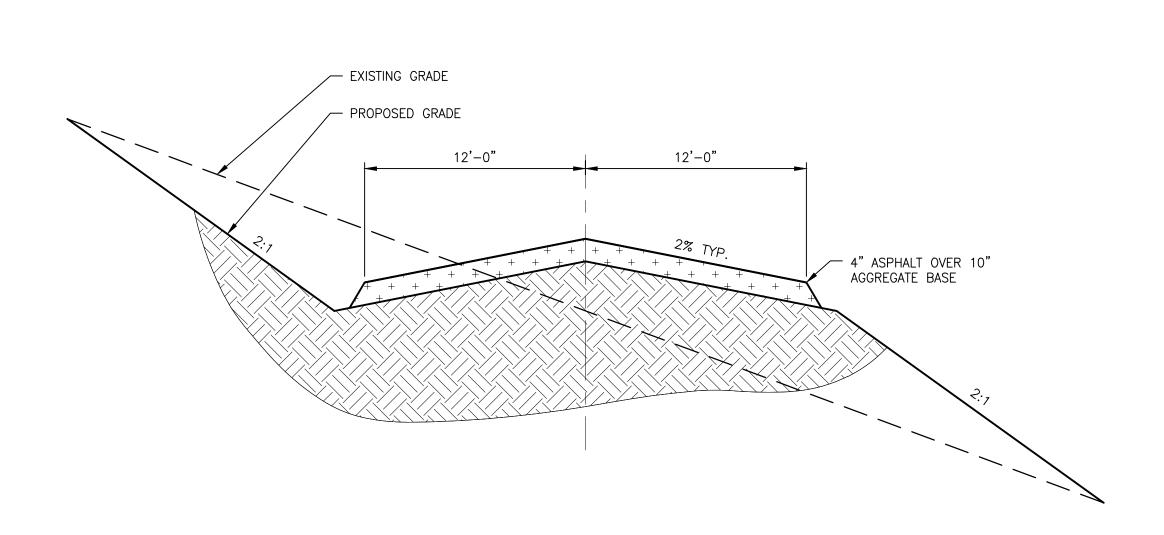

TYPICAL ROAD SECTION

DETAIL 3

NOTES:

- 1. DETAILS BASED ON BURNS & MCDONNELL DESIGN STANDARDS. VERIFY IN LATER PHASES OF DESIGN.
- 2. AT ROADWAY CROSSINGS, BACKFILL WITH COMPACTED CRUSHED AGGREGATE BASE ROCK OR FLOWABLE FILL.
- 3. GRANULAR BEDDING MATERIAL FOR ALL NON-OIL PIPES SHALL BE CRUSHED ROCK CONFORMING TO ASTM C33 COARSE AGGREGATE, SIZE NO. 67.

05/13/25 DESIGNED: J.BAKKER 05/13/25 (SoCalGas DRAWN: M.RIZO 05/16/25 CHECKED: S.HOPE PROJ APV: A Sempra Energy utility 1 07/25/2025 MCR SLH ISSUED FOR REVIEW SCG ENG APV: ISSUED FOR DR-001 RESPONSE ENG FILE NO: E15043 0 | 07/02/2025 | MCR | JBB |

ROAD & UTILITY DETAILS


VENTURA COMPRESSOR STATION

MODERNIZATION PROJECT

AVOCADO SITE

DWG CLASS: 9,39 DWG DIST: 114 DRAWING NUMBER 152084-7131-D-SKT C:\Users\mcrizo\Burns & McDonnell\SoCalGas Ventura EPC Execution — Documents\CPUC Support\Design\Civil — Structural\CAD\Avocado\152084—7131—D-SKT.dwg, 7/30/2025 8:21 AM, Rizo, Mike C.

DRAWING NUMBER	REFERENCE DRAWING DESCRIPTION
152084-7004-D-SKT	CONCEPTUAL PIPELINE & UTILITY PLAN

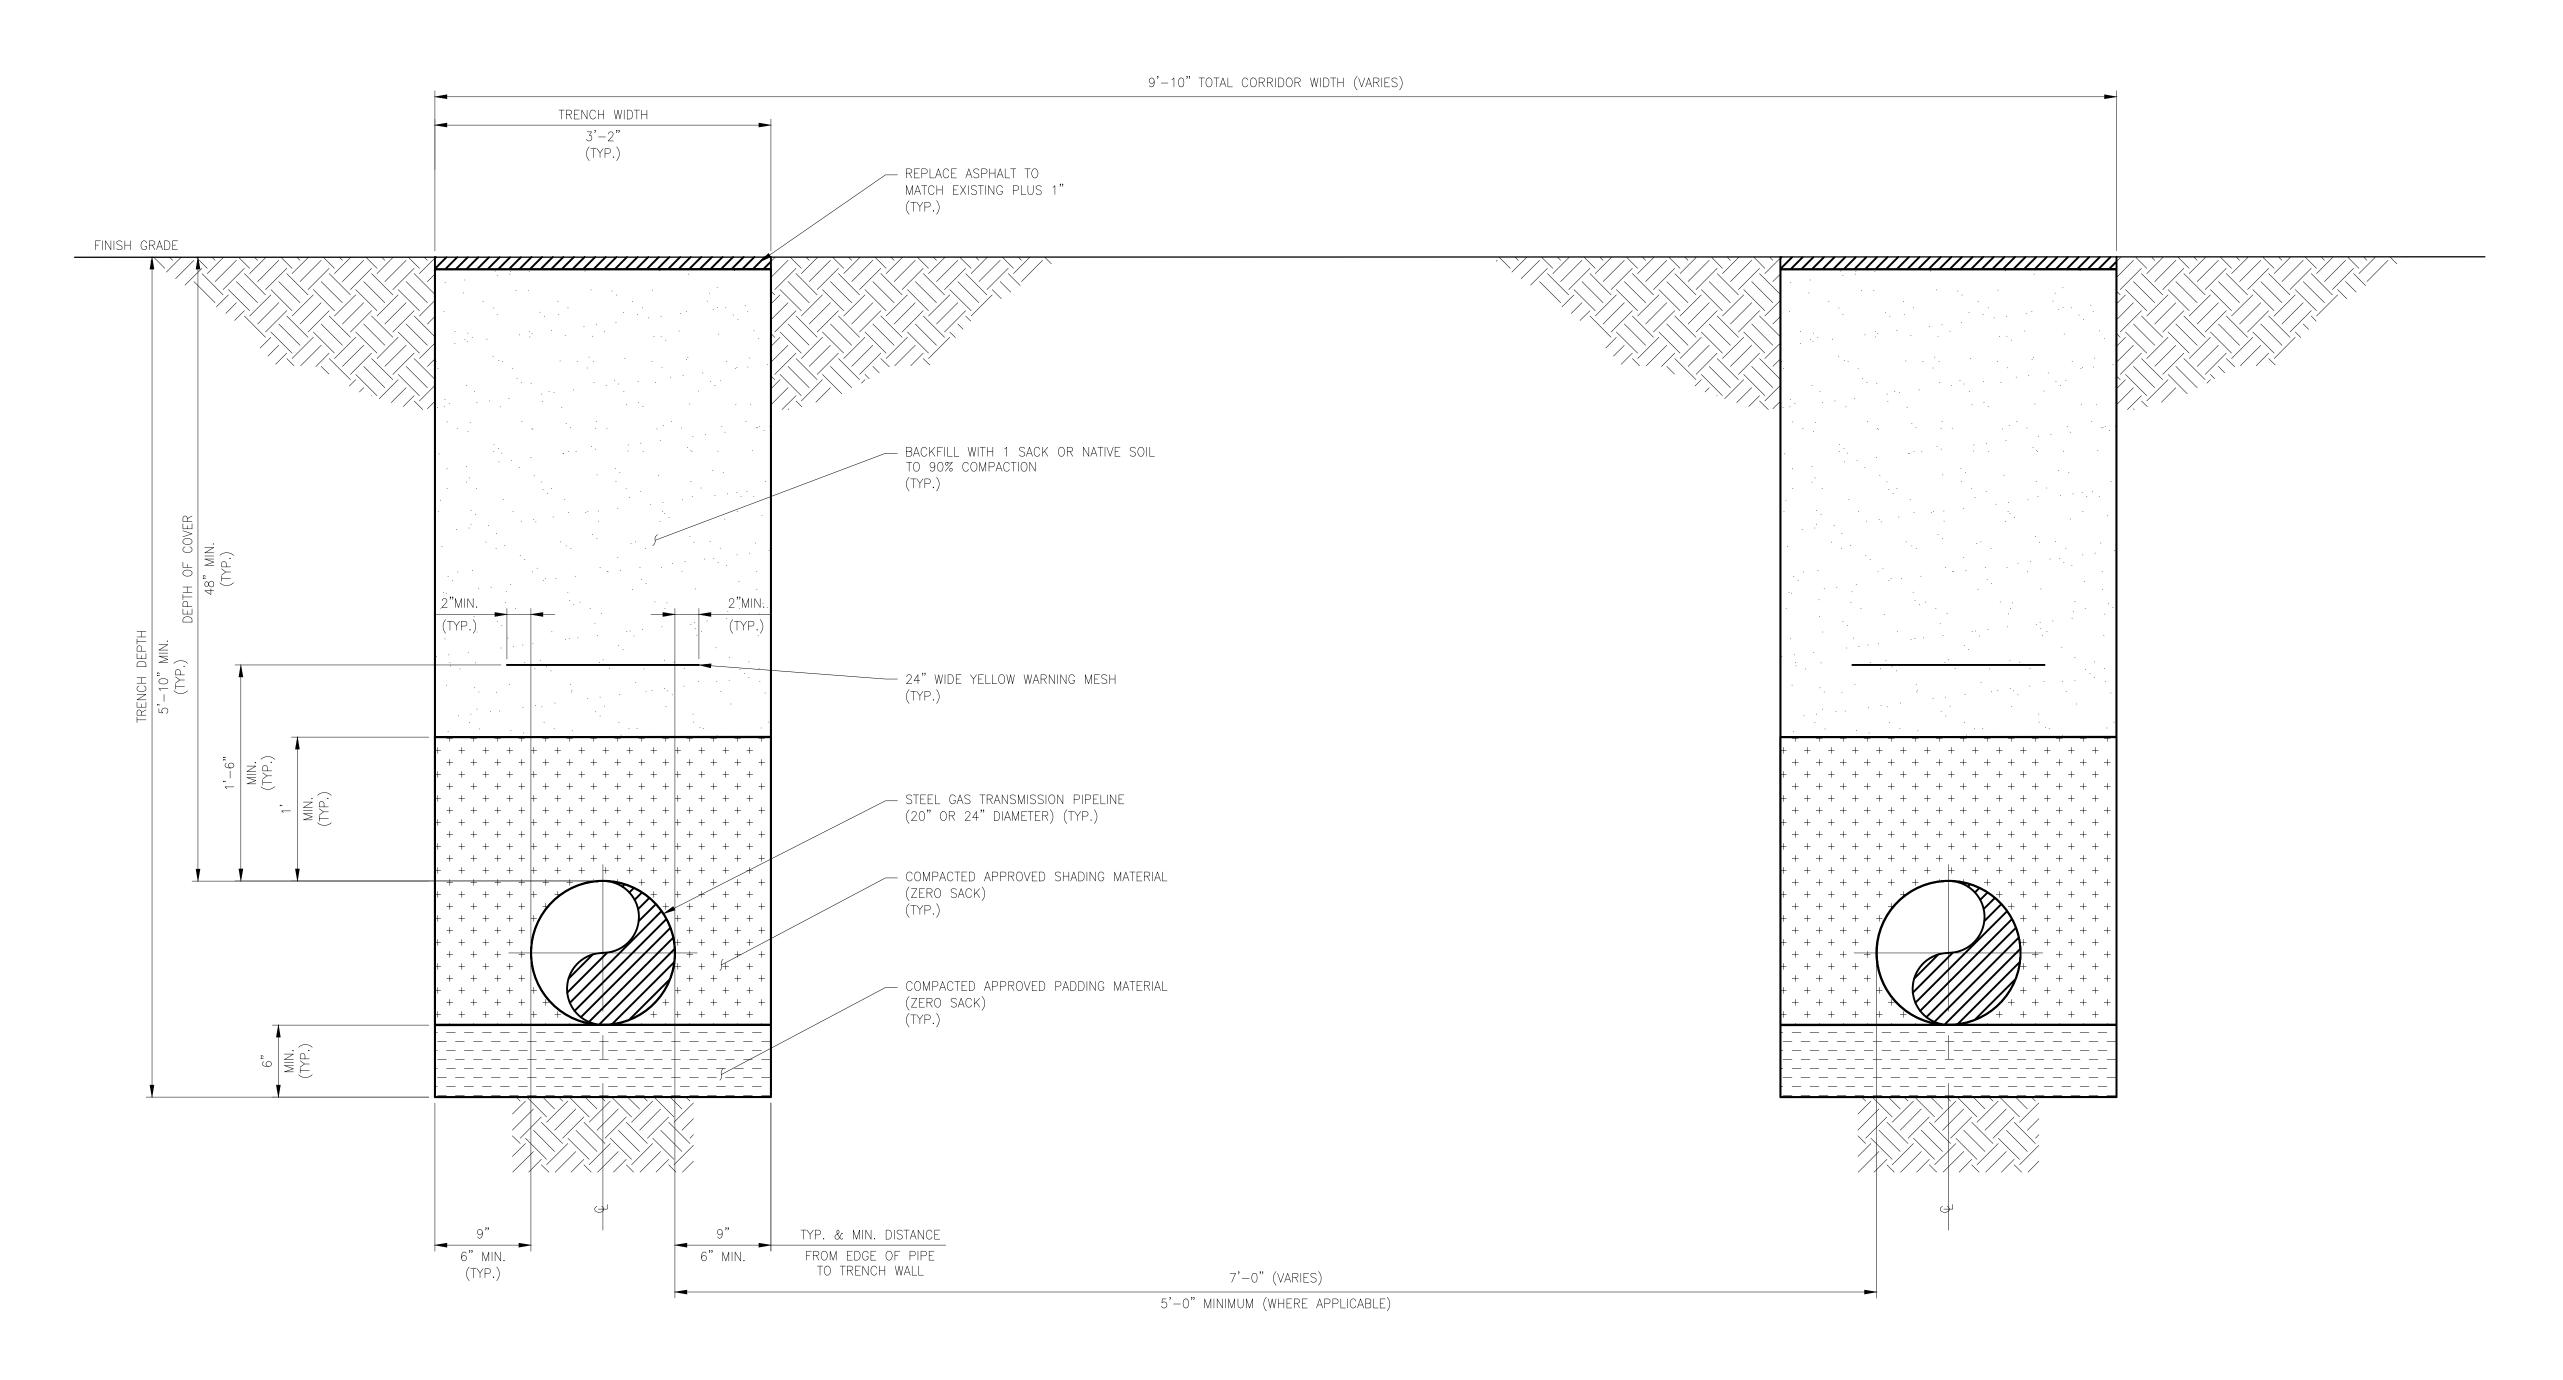

TYPICAL TWO GAS PIPELINES CORRIDOR DETAIL



- 1. DESIGN CODE AND GENERAL REQUIREMENTS:
- A. US DOT 49CFR192 (LATEST EDITION) TRANSPORTATION OF NATURAL AND OTHER GAS BY PIPELINE
- B. ASME B31.8 (LATEST EDITION) GAS TRANSMISSION AND DISTRIBUTION PIPING SYSTEMS C. CALIFORNIA PÙBLIC UTILITY CÓMMISSION G.O. 112E
- D. FEDERAL OCCUPATIONAL SAFETY AND HEALTH STANDARDS ACT (OSHA)
- E. CALIFORNIA STATE INDUSTRIAL SAFETY ORDERS

05/13/25 DESIGNED: M.RIZO DRAWN: M.RIZO 05/13/25 05/16/25 CHECKED: T.McADORY PROJ APV: SCG ENG APV: ENG FILE NO: 0 |07/02/2025 | MCR | TRM | ISSUED FOR DR-001 RESPONSE DATE DRAWN CHECKED PRJ APV SCG APV ENG FILE NO

VENTURA COMPRESSOR STATION MODERNIZATION PROJECT AVOCADO SITE TWO GAS PIPELINES CORRIDOR DETAIL

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